



Existing

DO NOT SCALE


- SPECIFICATION & CONSTRUCTION NOTES:**
- GENERAL**
1. These notes are intended to augment drawings and specifications. Where conflict of requirements exists the order of precedence shall be as shown in the specifications. Otherwise the strictest provision shall govern.
 2. This drawing is to be read in conjunction with all other relevant Engineering and Architectural drawings.
 3. Drawings not to be scaled. All dimensions to be checked on site by the Contractor. Any discrepancies to be notified to the Building Designer and further instructions obtained before work is commenced.
 4. The structure is designed to be self-supporting and stable after the building is fully complete. It is the Contractor's sole responsibility to determine the erection procedure and sequence and ensure that the building and its components are safe during erection. This includes the addition of whatever temporary bracing, guys or tie-downs which may be necessary, such material remaining the property of the Contractor upon completion.
 5. This drawing represents a detailed dimensional measurement survey of the physical dimensions of the existing property. This drawing does not and is not intended to express any opinion on the physical, superficial or structural condition of the premises depicted.
 6. This drawing is to be read in conjunction with all other relevant drawings.

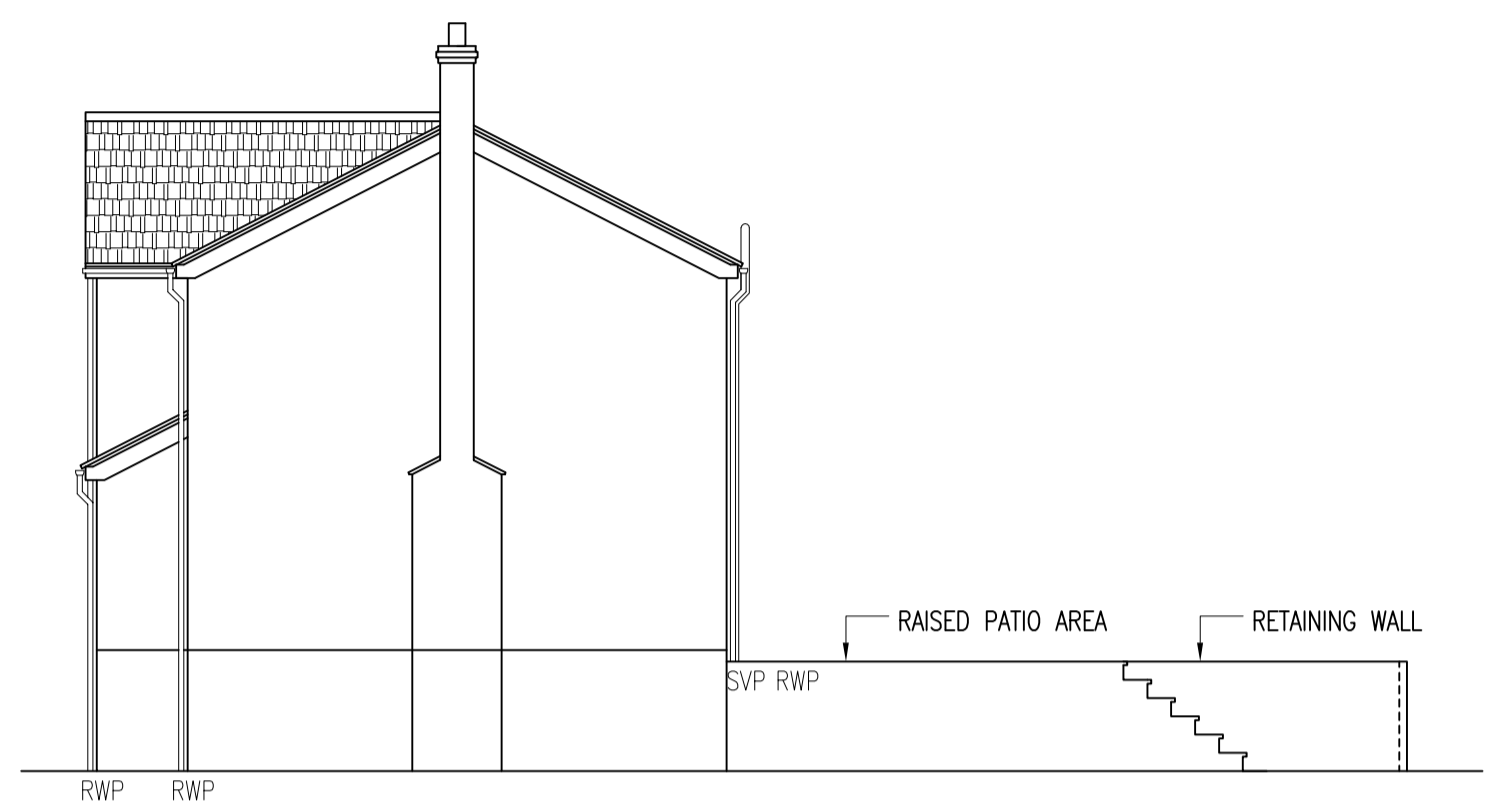



South West Elevation
Scale 1:100

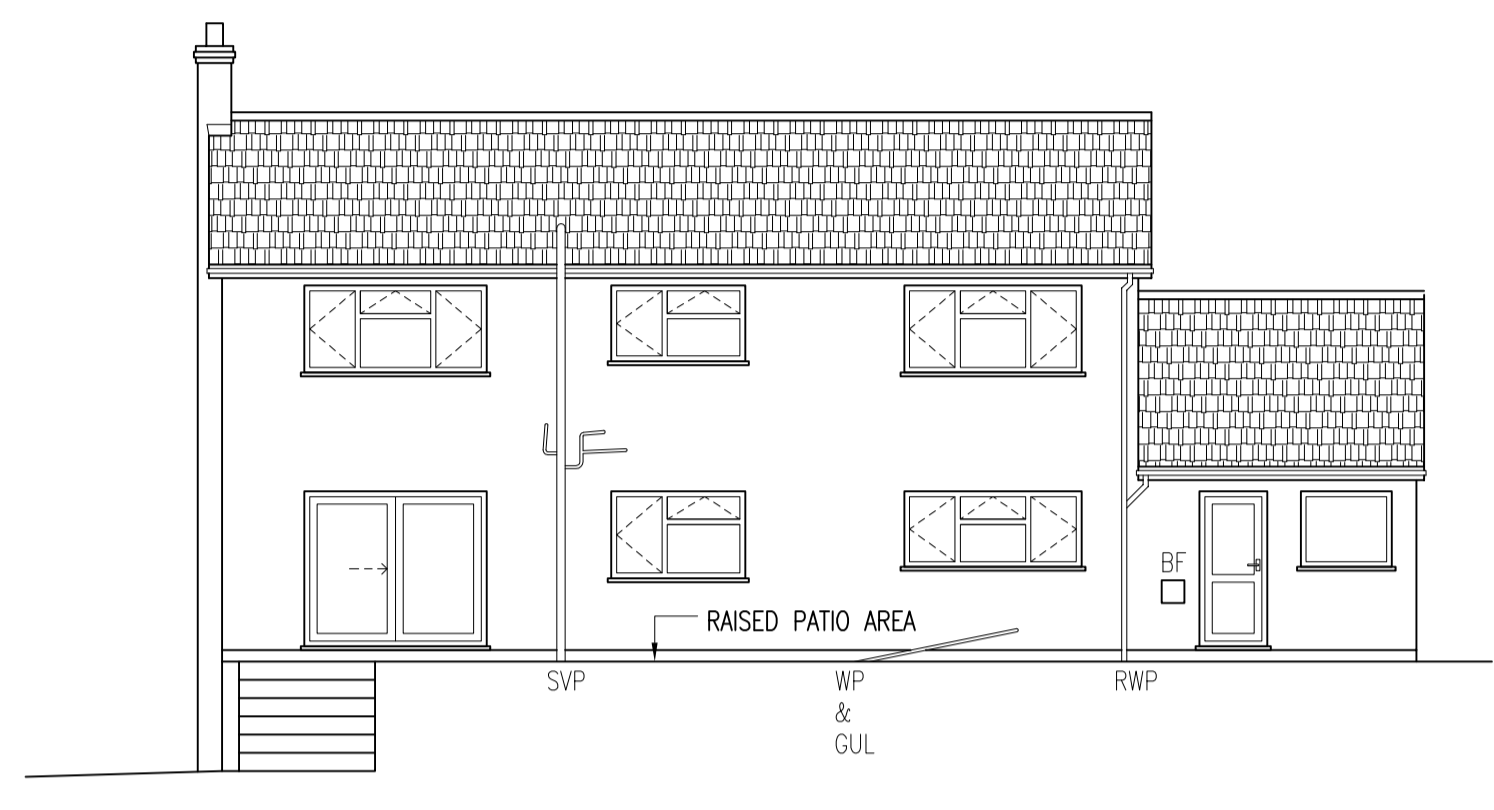


South East Elevation
Scale 1:100

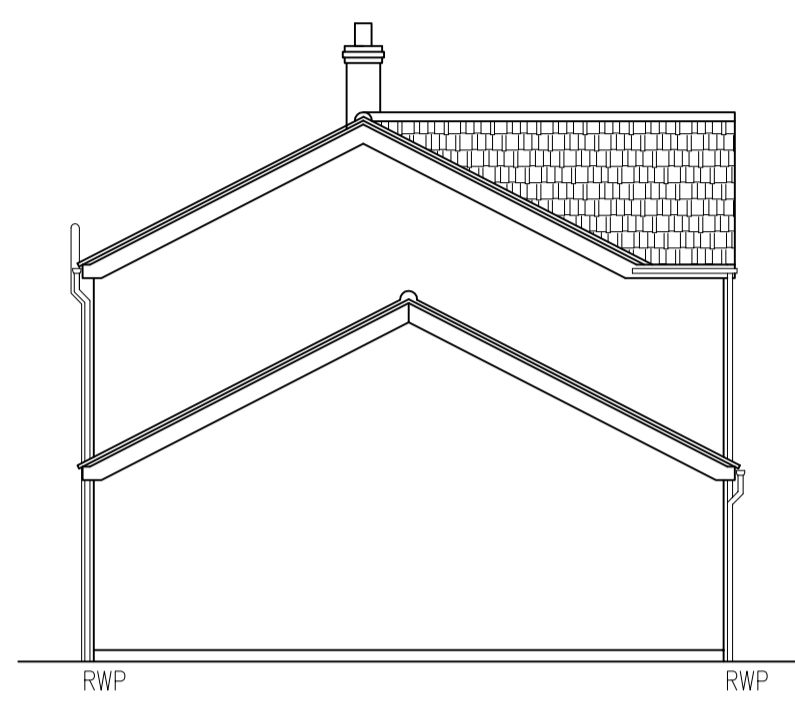

North East Elevation
Scale 1:100

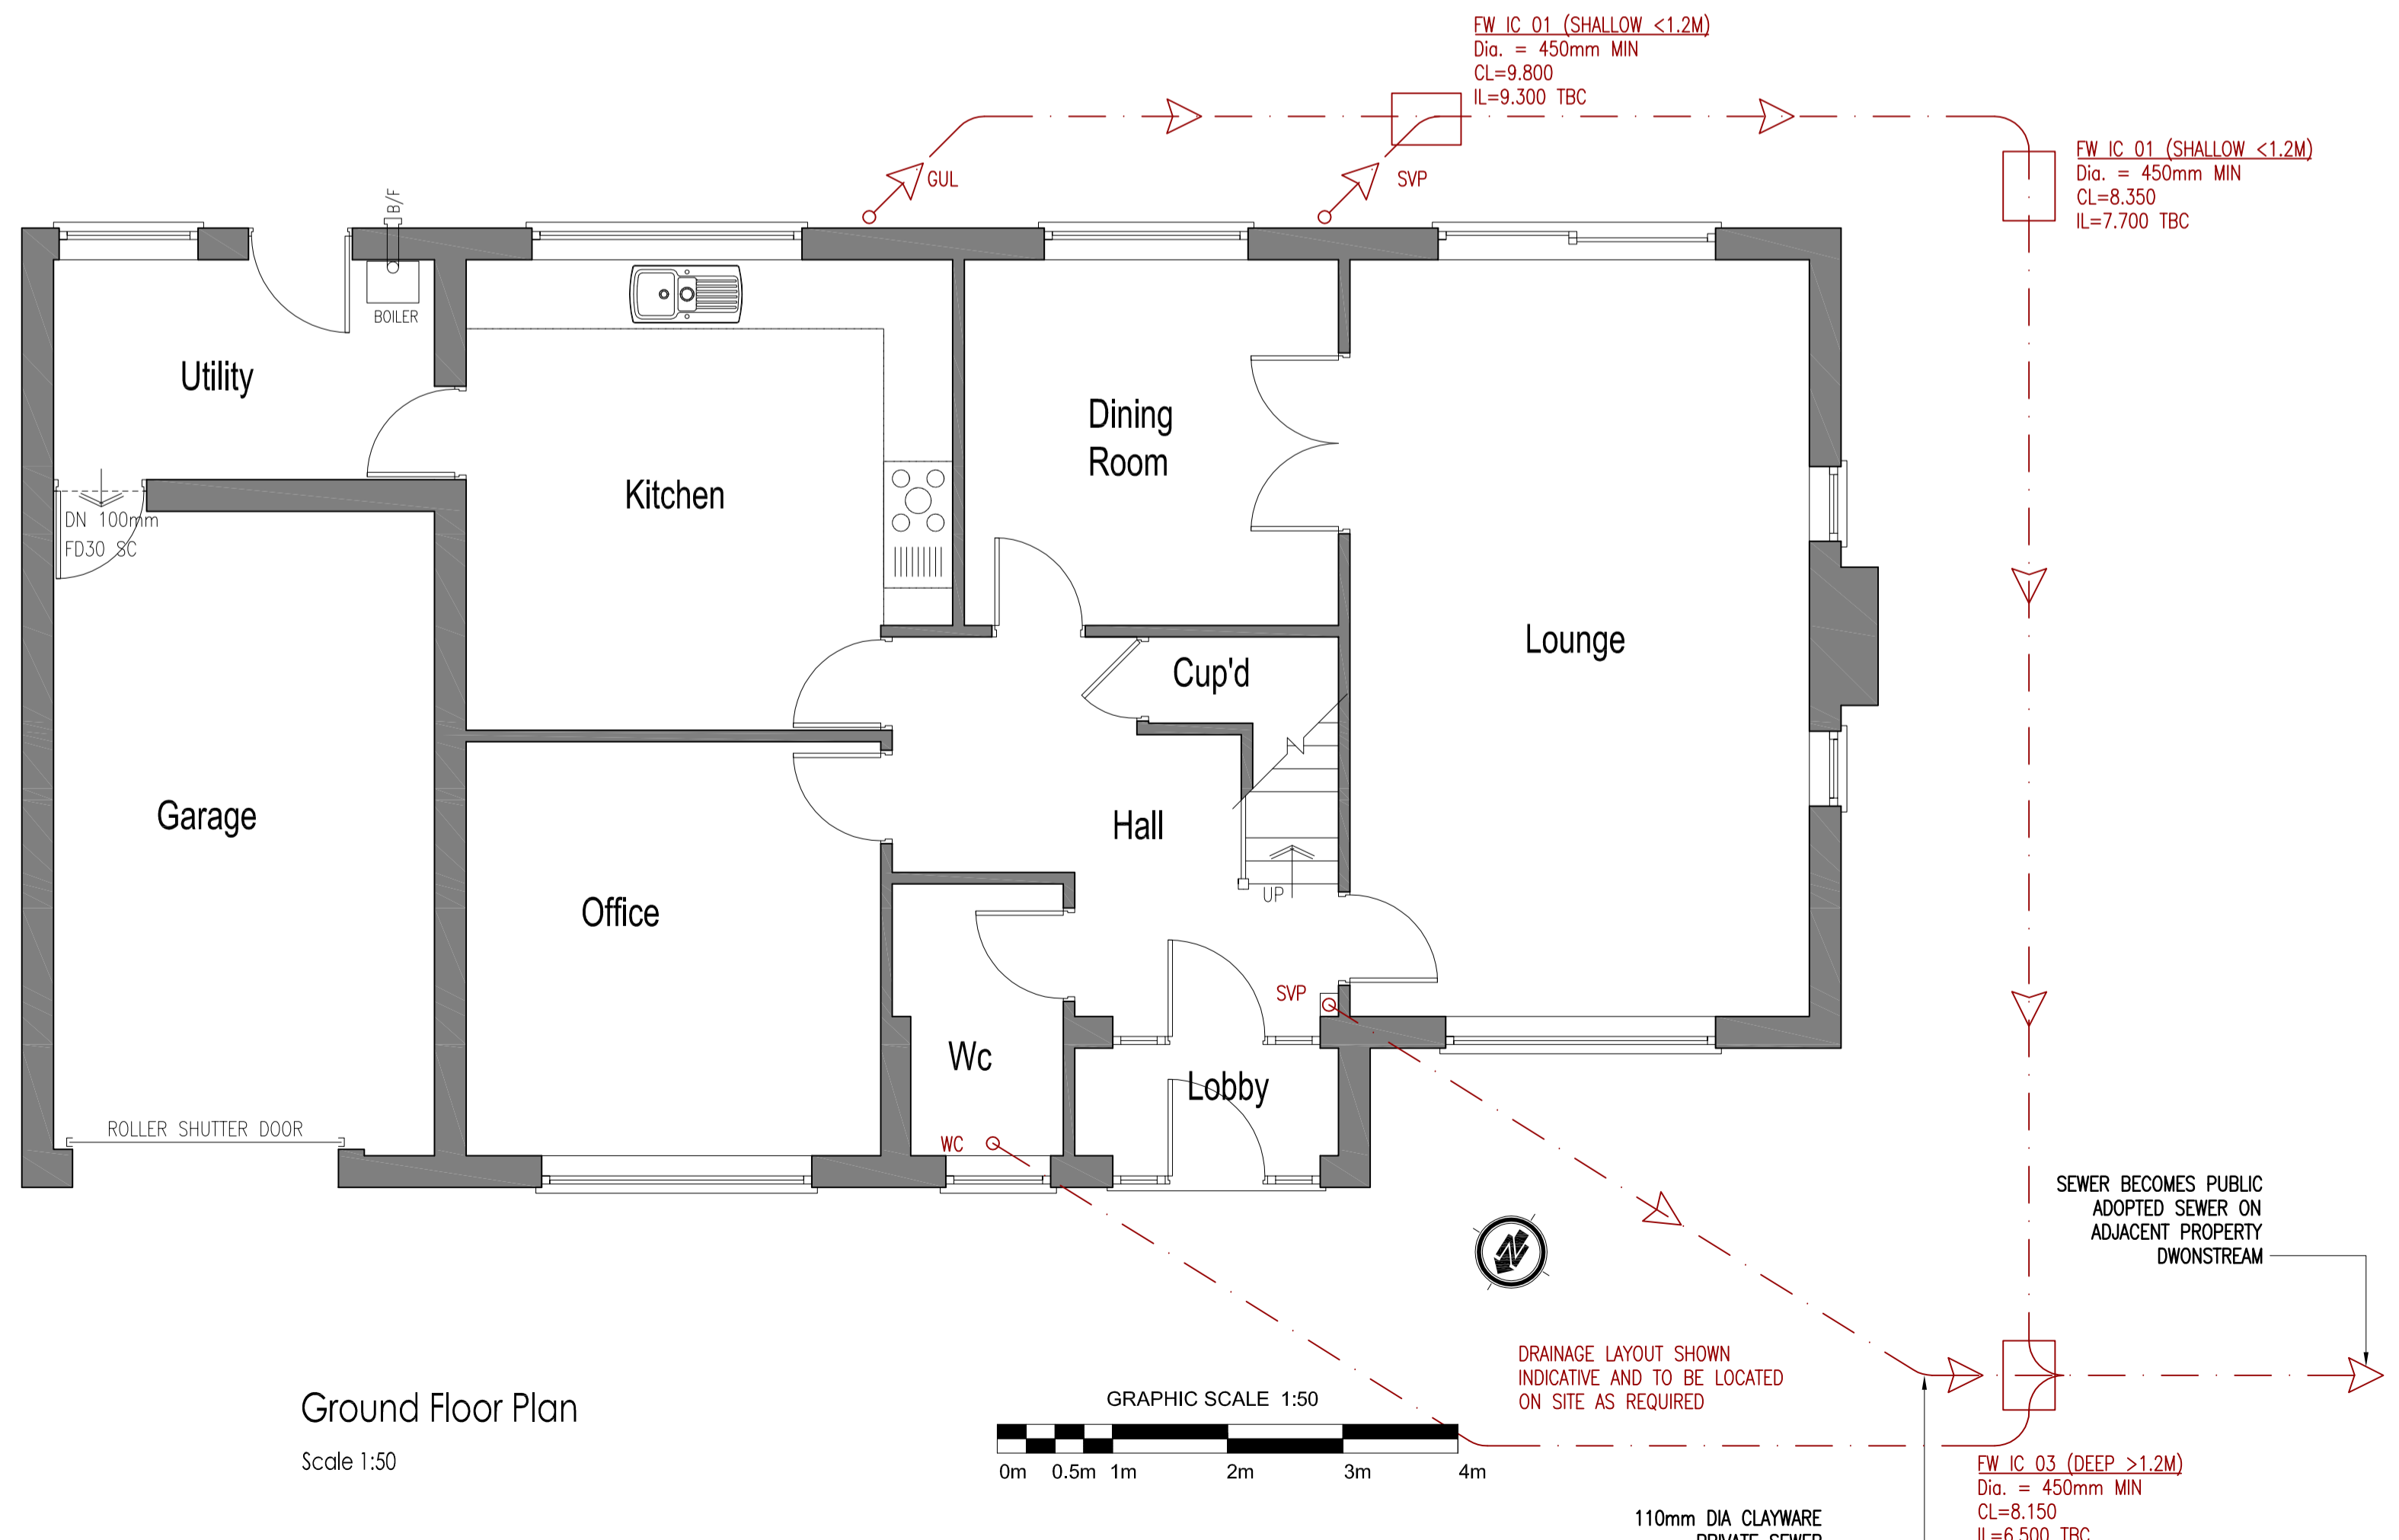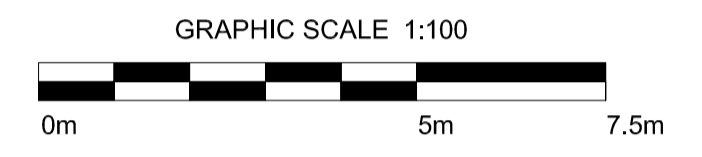

Ground Floor Plan
Scale 1:50

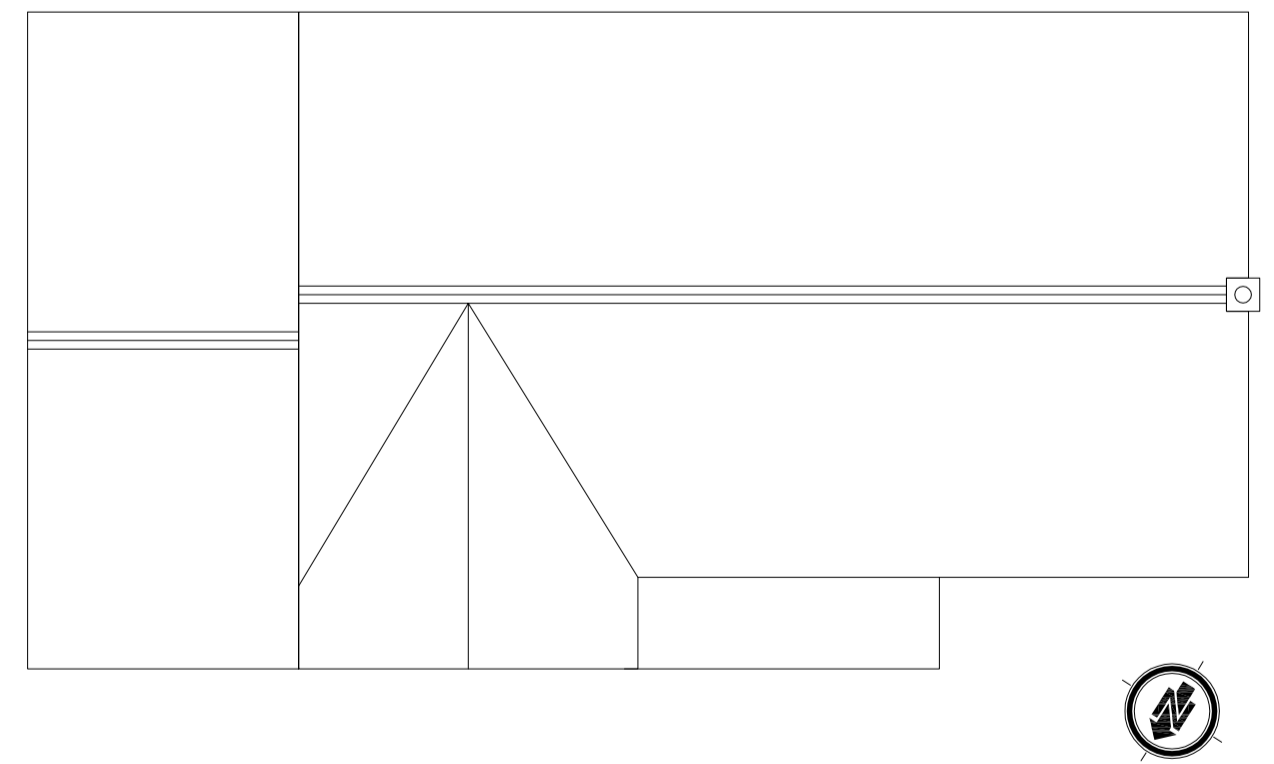

Roof Plan
Scale 1:100

D	08.08.18	TAS	Initial Issue	TAS	TAS
REV	DATE	BY	DESCRIPTION	CHK	APD
DRAWING STATUS: INITIAL ISSUE					
		FF2/2A School Court Wrawby Street Brigg North Lincolnshire DN20 8JW t: +44(0)1652 659467 f: +44(0)1652 659467 e: tasbuildingdesign@hotmail.co.uk			
CLIENT: MR D AITKEN					
PROJECT: 4 DUNSTAN HILL, KIRTON IN LINDSEY DN21 4DU					
TITLE: SURVEY OF EXISTING					
SCALE @ SIZE:	AS SHOWN @ A1	CHECKED:	TAS	APPROVED:	TAS
CAD FILE:	13209/Org/Arch	DESIGN/DRAWN:	TAS/ts	DATE:	AUG 2018
PROJECT No:	13009	DRAWING No:	A002	REV:	-
© TAS BUILDING DESIGN					

ORIGINAL IF RED

13009/A002