


NOTES:

1. CONTAINS ORDNANCE SURVEY DATA CROWN COPYRIGHT AND DATABASE RIGHTS 2021 - ORDNANCE SURVEY 0100031673.
2. COORDINATES SHOWN RELATE TO OS FLAT GRID U.N.O.
3. THE SITE IS CENTERED AT NGR: TA 16678 17462 E
4. DRAWING IS FOR PLANNING PURPOSES ONLY.

- KEY**
- SITE RED-LINE BOUNDARY
 - TEMPORARY CONSTRUCTION LAYDOWN
 - FLUE GAS HANDLING
 - UTILITIES / ACCESS
 - TEMPORARY CAR PARK
 - HV TRANSFORMERS / TIE-INS
 - PIPING TIE-INS
 - CONTROL ROOM MODIFICATION
 - TEMPORARY WORK AREA ACCESS (UNSHADED AREAS WITHIN RED-LINE BOUNDARY)

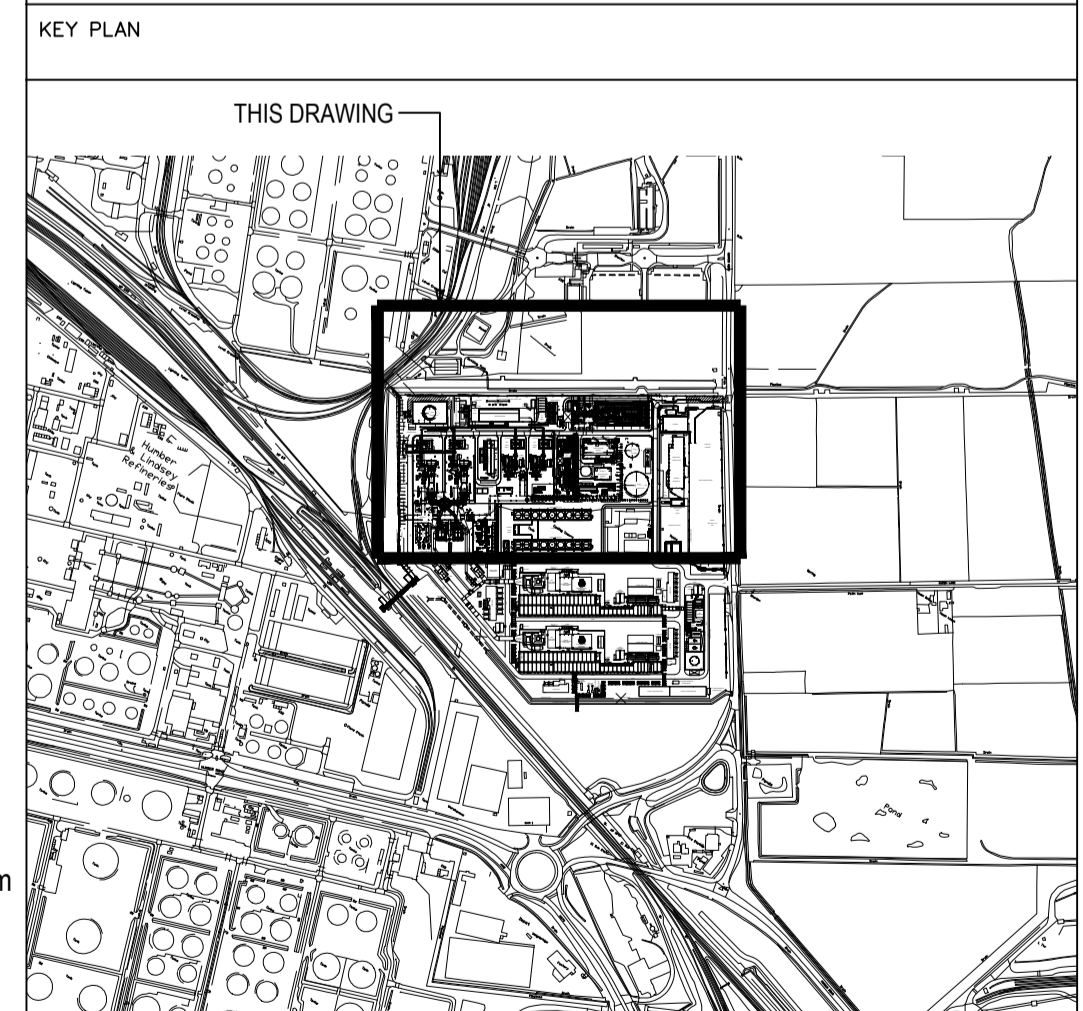

								A1 SHT	SCALE: 1:1000	ENGINEERING AND PERMIT STAMPS (As Required)	CUSTOMER	DRG TITLE	
												HZ-VPI-I PCC PROJECT PARAMETER / ZONING PLANNING DRAWING PLAN - SHEET 1	
										<small>*This drawing is prepared solely for the use of the contractual customer of Worley and Worley assumes no liability to any other party for any representations contained in this drawing.*</small>			
1	15/02/23	FOR USE	NG	CFT	NG	CFT	AG	415000-00201-8820-01-0001	HZ-VPI-I PCC PROJECT - PARAMETER / ZONING PLANNING - KEY PLAN	DRG No 415000-00201-8820-01-0002 REV 1			
0	03/02/23	FOR USE	NG	CFT	NG	CFT	AG	415000-00201-8230-01-0002	HZ-VPI-I PCC PROJECT - PLOT PLAN				
A	04/10/22	FOR REVIEW	NG	CFT	NG	CFT	AG	415000-00201-8230-01-0001	HZ-VPI-I PCC PROJECT - SITE PLAN				
REV	DATE	PURPOSE	DRAWN	DRAFT CHK	DESIGNED	ENG CHK	APPROVED	REF DRAWING No	REFERENCE DRAWING TITLE	WORLEY PROJECT No. 415000-00201			