


N. 4732.000 (TO SITE GRID) - MATCHLINE - CONTINUED ON DRAWING 415000-00201-8820-01-0002

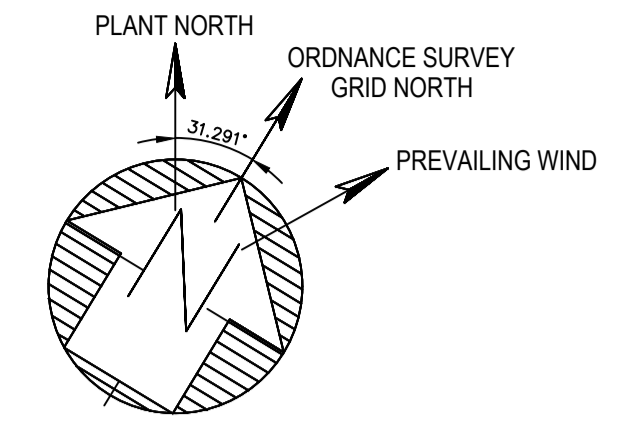


NOTES:

1. CONTAINS ORDNANCE SURVEY DATA CROWN COPYRIGHT AND DATABASE RIGHTS 2021 - ORDNANCE SURVEY 0100031673.
2. COORDINATES SHOWN RELATE TO OS FLAT GRID U.N.O.
3. THE SITE IS CENTERED AT NGR: TA 16678 17462 E
4. DRAWING IS FOR PLANNING PURPOSES ONLY.

KEY

- SITE RED-LINE BOUNDARY
- CARBON CAPTURE PLANT
- TEMPORARY CONSTRUCTION LAYDOWN
- DITCH AND EASEMENT (INCLUDING TEMPORARY DITCH CROSSINGS FOR CONSTRUCTION ACCESS. TO BE REMOVED UPON COMPLETION OF CONSTRUCTION)
- FLUE GAS HANDLING
- UTILITIES / ACCESS
- SITE OFFICES AND WELFARE
- TEMPORARY CAR PARK
- ABSORBER TOWER LIMITS OF DEVIATION WITHIN CC PLANT
- STRIPPER COLUMN LIMITS OF DEVIATION WITHIN CC PLANT
- CO2 VENT STACK LIMITS OF DEVIATION WITHIN CC PLANT
- TEMPORARY WORK AREA ACCESS (UNSHADED AREAS WITHIN RED-LINE BOUNDARY)

KEY PLAN

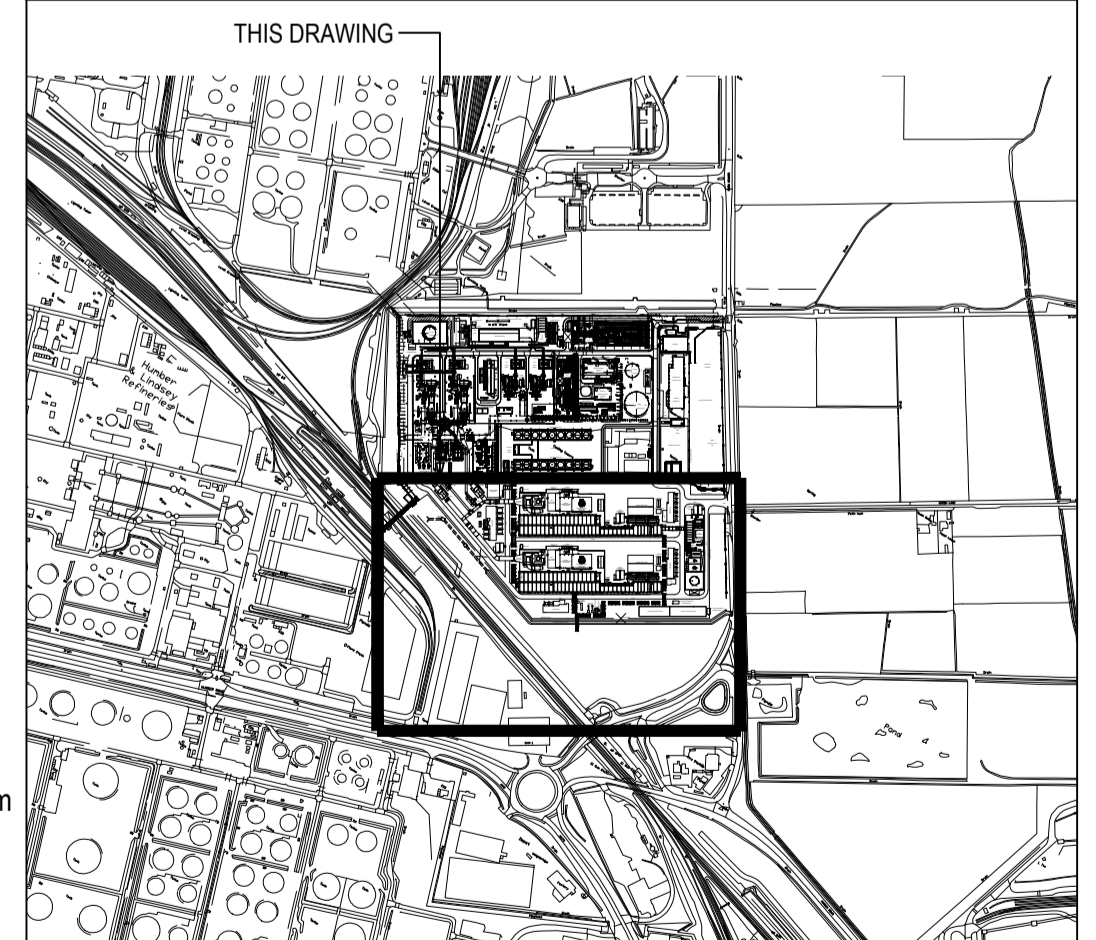

E. 4964.000 (TO SITE GRID) - MATCHLINE - DRAWING LIMIT

E. 5564.000 - (TO SITE GRID) MATCHLINE - DRAWING LIMIT

N. 4314.500 (TO SITE GRID) - MATCHLINE - DRAWING LIMIT



REV	DATE	PURPOSE	DRAWN	DRAFT	CHK	DESIGNED	ENG	CHK	APPROVED	REF DRAWING No	REFERENCE DRAWING TITLE	A1 SHT	SCALE: 1:1000	ENGINEERING AND PERMIT STAMPS (As Required)	CUSTOMER	DRG TITLE	DRG No	REV
1	15/02/23	FOR USE	NG	CFT	NG	CFT	AG			415000-00201-8820-01-0001	HZ-VPH PCC PROJECT - PARAMETER / ZONING PLANNING - KEY PLAN		 	 	HZ-VPI-I PCC PROJECT PARAMETER / ZONING PLANNING DRAWING PLAN - SHEET 2	415000-00201-8820-01-0003	1	
0	03/02/23	FOR USE	NG	CFT	NG	CFT	AG		415000-00201-8230-01-0002	HZ-VPH PCC PROJECT - PLOT PLAN								
A	04/10/22	FOR REVIEW	NG	CFT	NG	CFT	AG		415000-00201-8230-01-0001	HZ-VPH PCC PROJECT - SITE PLAN								
												WORLEY PROJECT No.	<small>*This drawing is prepared solely for the use of the contractual customer of Worley and Worley assumes no liability to any other party for any representations contained in this drawing.*</small>					
												415000-00201						